

DEPARTMENT OF REGULATORY AND ECONOMIC RESOURCES (RER) BOARD AND CODE ADMINISTRATION DIVISION

NOTICE OF ACCEPTANCE (NOA)

MIAMI-DADE COUNTY, FLORIDA PRODUCT CONTROL SECTION 11805 SW 26 Street, Room 208 T (786) 315-2590 F (786) 315-2599

www.miamidade.gov/economy

Tischler und Sohn (USA) Ltd. Six Suburban Avenue Stamford, CT 06901

Scope:

This NOA is being issued under the applicable rules and regulations governing the use of construction materials. The documentation submitted has been reviewed and accepted by Miami-Dade County RER-Product Control Section to be used in Miami-Dade County and other areas where allowed by the Authority Having Jurisdiction (AHJ).

This NOA shall not be valid after the expiration date stated below. The Miami-Dade County Product Control Section (In Miami-Dade County) and/ or the AHJ (in areas other than Miami-Dade County) reserve the right to have this product or material tested for quality assurance purposes. If this product or material fails to perform in the accepted manner, the manufacturer will incur the expense of such testing and the AHJ may immediately revoke, modify, or suspend the use of such product or material within their jurisdiction. RER reserves the right to revoke this acceptance, if it is determined by Miami-Dade County Product Control Section that this product or material fails to meet the requirements of the applicable building code. This product is approved as described herein, and has been designed to comply with the Florida Building Code, including the High Velocity Hurricane Zone.

DESCRIPTION: Series "Weight & Chain System" Single & Double Hung Wood Window - L.M.I.

APPROVAL DOCUMENT: Drawing No. 1828, Series titled "Single & Double Weight & Chain System Hung Impact Window", sheets 01 through 09 of 09, dated 07/02/12 with the latest revision dated 06/04/13, prepared by W. W. Schaefer Engineering & Consulting, P. A., signed and sealed by Warren W. Schaefer, P. E., bearing the Miami—Dade County Product Control Section Approval stamp with the Notice of Acceptance number and Approval date by the Miami—Dade County Product Control Section.

MISSILE IMPACT RATING: Large and Small Missile Impact Resistant

LABELING: Each unit shall bear a permanent label with the manufacturer's name or logo, city, state, model/ series, and following statement: "Miami-Dade County Product Control Approved", unless otherwise noted herein.

RENEWAL of this NOA shall be considered after a renewal application has been filed and there has been no change in the applicable building code negatively affecting the performance of this product.

TERMINATION of this NOA will occur after the expiration date or if there has been a revision or change in the materials, use, and/or manufacture of the product or process. Misuse of this NOA as an endorsement of any product, for sales, advertising or any other purposes shall automatically terminate this NOA. Failure to comply with any section of this NOA shall be cause for termination and removal of NOA.

ADVERTISEMENT: The NOA number preceded by the words Miami-Dade County, Florida, and followed by the expiration date may be displayed in advertising literature. If any portion of the NOA is displayed, then it shall be done in its entirety.

INSPECTION: A copy of this entire NOA shall be provided to the user by the manufacturer or its distributors and shall be available for inspection at the job site at the request of the Building Official. This NOA consists of this page 1 and evidence page E-1, as well as approval document mentioned above. The submitted documentation was reviewed by **Jaime D. Gascon, P. E.**



JUASION GLUTS

NOA No. 13-0304.08 Expiration Date: June 13, 2018 Approval Date: June 13, 2013 Page 1

Tischler und Sohn (USA) Ltd.

NOTICE OF ACCEPTANCE: EVIDENCE SUBMITTED

A. DRAWINGS

- 1. Manufacturer's die drawings and sections.
- 2. Drawing No. 1828, Series titled "Single & Double Weight & Chain System Hung Impact Window", sheets 01 through 09 of 09, dated 07/02/12 with the latest revision dated 06/0/13, prepared by W. W. Schaefer Engineering & Consulting, P. A., signed and sealed by Warren W. Schaefer, P. E.

B. TESTS

- 1. Test reports on: 1) Air Infiltration Test, per FBC, TAS 202-94
 - 2) Uniform Static Air Pressure Test, Loading per FBC, TAS 202-94
 - 3) Water Resistance Test, per FBC, TAS 202-94
 - 4) Large Missile Impact Test per FBC, TAS 201-94
 - 5) Cyclic Wind Pressure Loading per FBC, TAS 203-94
 - 6) Forced Entry Test, per FBC 2411.3.2.1, and TAS 202-94

along with marked-up drawings and installation diagram of a wood hung window, prepared by Architectural Testing, Inc., Test Report No. ATI-C261.01-109-18, dated 11/20/12, signed and sealed by Michael D. Stremmel, P. E.

C. CALCULATIONS

- 1. Anchor calculations and structural analysis, complying with FBC-2010, dated 09/25/12, prepared by W. W. Schaefer Engineering & Consulting, P. A., signed and sealed by Warren W. Schaefer, P. E.
- 2. Glazing complies with ASTM E1300-04

D. QUALITY ASSURANCE

1. Miami-Dade Department of Regulatory and Economic Resources (RER).

E. MATERIAL CERTIFICATIONS

1. Notice of Acceptance No. 12–1231.08 issued to Eastman Chemical Company (MA) for their "Saflex CP – Saflex and Saflex HP Composite Glass Interlayers with PET Core" dated 03/28/13, expiring on 12/11/18.

F. STATEMENTS

- 1. Statement letter of conformance with ANSI/ AAMA/ NWWDA 101/ I.S.2-97 and complying with FBC-2010, dated 10/09/12, issued by W. W. Schaefer Engineering & Consulting, P. A., signed and sealed by Warren W. Schaefer, P. E.
- Statement letter of no financial interest and independence, dated 10/09/12, issued by W. W. Schaefer Engineering & Consulting, P. A., signed and sealed by Warren W. Schaefer, P. E.
- 3. Laboratory compliance letter for Test Report No. ATI-C261.01-109-18, issued by Architectural Testing, Inc., dated 11/20/12, signed and sealed by Michael Stremmel, P.E.

G. OTHERS

1. None.

Jaime D. Gascon, P. E. Product Control Section Supervisor NOA No. 13-0304.08

Expiration Date: June 13, 2018

Approval Date: June 13, 2013

1. THESE WINDOW SYSTEMS HAVE BEEN TESTED, ANALYZED & APPROVED FOR DESIGN PRESSURES NOT TO EXCEED THOSE SHOWN IN THE "ALLOWABLE DESIGN PRESSURE TABLE(S)".

OPENINGS, BUCKING & BUCKING FASTENERS MUST BE PROPERLY DESIGNED & INSTALLED TO TRANSFER WIND LOADS TO THE

3. ALL HARDWARE & FASTENERS SHALL BE IN ACCORDANCE WITH THESE DRAWINGS & SHALL NOT VARY UNLESS SPECIFICALLY MENTIONED ON THE DRAWINGS. SPECIFIED ANCHOR EMBED TO BASE MATERIAL SHALL BE BEYOND WALL FINISH OR STUCCO. 4. THE DETAILS & SPECIFICATIONS SHOWN HEREIN REPRESENT THE PRODUCTS TESTED & PROPOSED FOR WATER, AIR, IMPACT, CYCLIC & UNIFORM STATIC AIR PRESSURE TESTING IN CONFORMANCE WITH THE FLORIDA BUILDING CODE PROTOCOLS TAS-201, 202 & 203 FOR LARGE

MISSILE IMPACT WINDOWS 5. THESE WINDOW SYSTEMS HAVE BEEN DESIGNED IN ACCORDANCE WITH AND MEET THE REQUIREMENTS OF THE FLORIDA BUILDING CODE (FBC) INCLUDING HIGH VELOCITY HURRICANE ZONES (HVHZ),

3. IMPACT SHUTTERS ARE NOT REQUIRED WITH THESE WINDOWS.

7. ALL ANCHORS SECURING WINDOW FRAME TO PRESSURE TREATED BUCKS OR WOOD FRAMING SHALL BE CAPABLE OF RESISTING

CORROSION CAUSED BY THE PRESSURE TREATING CHEMICALS IN THE WOOD.

8. DEFERMINE THE POSITIVE & NEGATIVE DESIGN LOADS TO USE WHEN REFERENCING THESE DOCUMENTS IN ACCORDANCE WITH THE GOVERNING CODE AND GOVERNING WIND VELOCITY. FOR WIND LOAD CALCULATIONS IN ACCORDANCE WITH THE FLORIDA BUILDING CODE, A DIRECTIONALITY FACTOR OF Kd = 0.85 MAY BE APPLIED PER THE ASCE-7 STANDARD.

9. NO INCREASE IN ALLOWABLE STRESS HAS BEEN USED IN THE CERTIFICATION OF THIS PRODUCT. WIND LOAD DURATION FACTOR Cd ==

1.6 WAS USED FOR WOOD SCREW ANALYSIS ONLY.


10. MATERIALS, INCLUDING BUT NOT LIMITED TO STEEL SCREWS, THAT COME INTO CONTACT WITH OTHER DISSIMILAR MATERIALS SHALL MEET


THE REQUIREMENTS OF FLORIDA BUILDING CODE CHAPTER 20.

11. ALL WOOD MEMBERS OF WINDOWS THAT MAY POSSIBLY COME INTO CONTACT WITH MASONRY OR CONCRETE SUBSTRATES, ARE SUBJECT TO MOISTURE &/OR ARE SUBJECT TO THE OUTSIDE ENVIRONMENT SHALL BE OF AN APPROVED DURABLE SPECIES OR BE TREATED IN AN APPROVED METHOD WITH AN APPROVED PRESERVATIVE PER FBC SECTION 2326.

FRAME AND	CHOR REQUIREMENTS TABLE		
OPENING TYPE (SUBSTRATE)	FRAME/CLIP/BRACKET TO OPENING FASTENER TYPE	MINIMUM EMBED	MINIMUM EDGE DIST.
	FRAME SCREWS		<u>_,</u>
MIN. 2X4 WOOD FRAME OR BUCK (MIN. GR. 3 & G=0.55)	NO. 14 SMS/WOOD SCREW OR 1/4" BTI SCREW	1 1/4"	3/4"
MIN. 16 GA. 33 KSI METAL STUD	1/4" GR. 5 SELF TAP/DRILLING SCREW	FULL	1/2"
MIN. 1/8" THK A36 STEEL	1/4" GR. 5 SELF TAP/DRILLING SCREW	FULL	1/2"
MIN. 1/8" THK 6063-T5 ALUM.	1/4" GR. 5 SELF TAP/DRILLING SCREW	FULL	1/2"
(3) C-90 CMU	(1) 1/4" CONCRETE SCREW	1 1/4"	2"
2500 PSI CONCRETE	(1) 1/4" CONCRETE SCREW	1 3/4"	2"
INSTA	LLATION CLIP SCREWS		
(2) MIN. 2X_ WOOD FRAME OR BUCK (MIN. GR. 3 & G=0.55)	NO. 12 SMS OR WOOD SCREW	1 3/8"	3/4"
MIN. 16 GA. 33 KSI METAL STUD	NO. 12 GR. 5 SELF TAP/DRILL SCREW	FULL	1/2"
MIN. 1/8" THK A36 STEEL	NO. 12 GR. 5 SELF TAP/DRILL SCREW	FULL	1/2"
MIN. 1/8" THK 6063-T5 ALUM.	NO. 12 GR. 5 SELF TAP/DRILL SCREW	FULL	1/2"
(3) C-90 CMU	(1) 1/4" CONCRETE SCREW	1 1/4"	2"
2500 PSI CONCRETE	(1) 1/4" CONCRETE SCREW	1 3/4"	2"
ВТ	I BRACKET SCREWS		
(2) MIN. 2X_ WOOD FRAME OR BUCK (MIN. GR. 3 & G=0.55)	NO. 8 SMS OR WOOD SCREW	1 3/8"	3/4"
MIN. 18 GA. 33 KSI METAL STUD	NO. 8 GR. 5 SELF TAP/DRILL SCREW	FULL	1/2"
MIN. 1/8" THK A36 STEEL	NO. 8 GR. 5 SELF TAP/DRILL SCREW	FULL	1/2"
MIN. 1/8" THK 6063-T5 ALUM.	NO. 8 GR. 5 SELF TAP/DRILL SCREW	FULL	1/2"
A	NGLE CLIP SCREWS		
MIN. 2X4 WOOD FRAME OR BUCK (MIN. GR. 3 & G=0.55)	NO. 8 SMS OR WOOD SCREW	1 5/16"	1/2"
MIN. 1/8" THK A36 STEEL	NO. 8 GR. 5 SELF TAP/DRILL SCREW	FULL	1/2"
MIN. 1/8" THK 6063-T5 ALUM.	NO. 8 GR. 5 SELF TAP/DRILL SCREW	FULL	1/2"
(1) CONCRETE SCREWS SHALL BE ELCO	ULTRACONS (C.S.), ELCO CRETE-FLEX (S	.s.). ITW	

- (1) CONCRETE SCREWS SHALL BE ELCO ULTRACONS (C.S.), ELCO CRETE-FLEX (S.S.), ITW RAMSET/RED HEAD TAPCONS (C.S. OR S.S.) OR HILTI KWIK-CON II (C.S OR S.S.).
- (2) 2X_, BUCKS SHALL BE OF A MINIMUM DEPTH, REQUIRED TO MEET ANCHOR EDGE DISTANCE
- (3) CMU IS NOT APPLICABLE AT HEAD OR SILL.

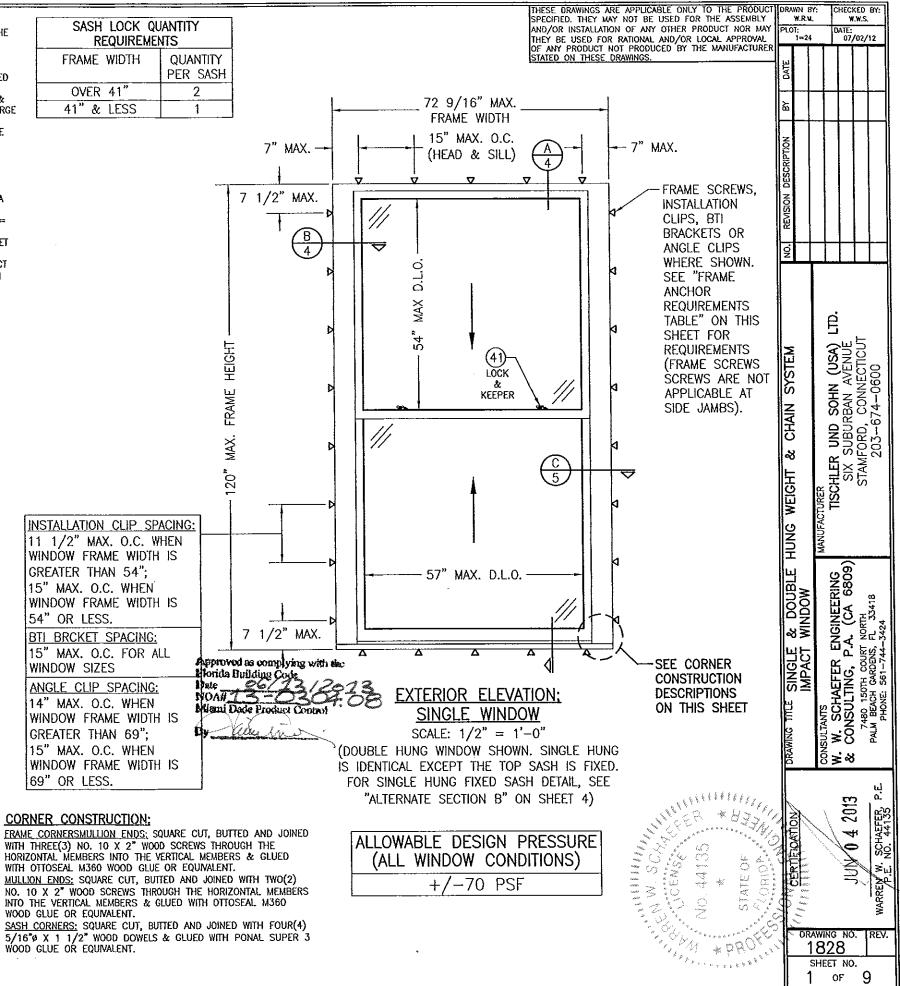

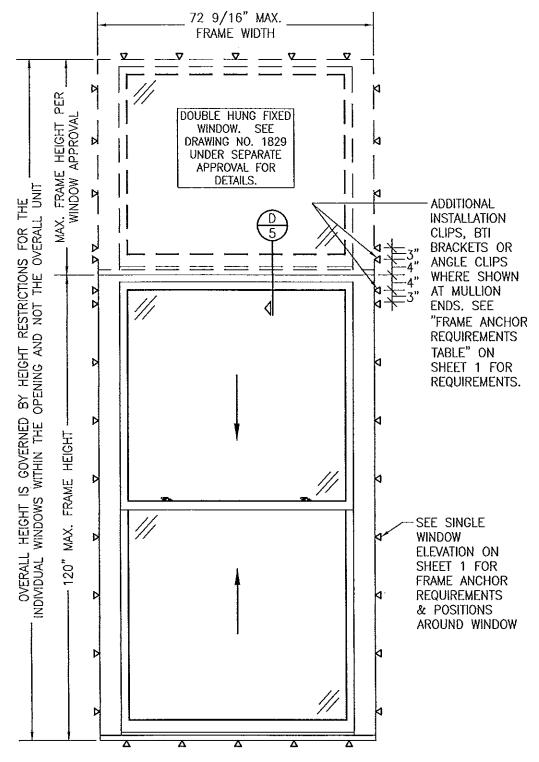


EXTERIOR ELEVATION; SINGLE WINDOW WITH TRANSOM

SCALE: 1/2" = 1'-0"


(DOUBLE HUNG WINDOW SHOWN. SINGLE HUNG WINDOW ALSO APPLIES) (FOR DETAIL NOT SHOWN, SEE SINGLE WINDOW ELEVATION ON SHEET 1)


Approved as complying with the Florida Building Code
Date
NOA#
Migni Dade Product Control


By Manual Control

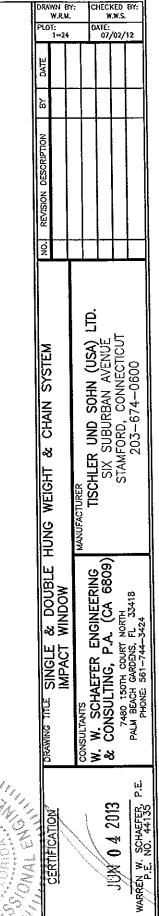



DRAWING NO. 1828 SHEET NO. 2 OF

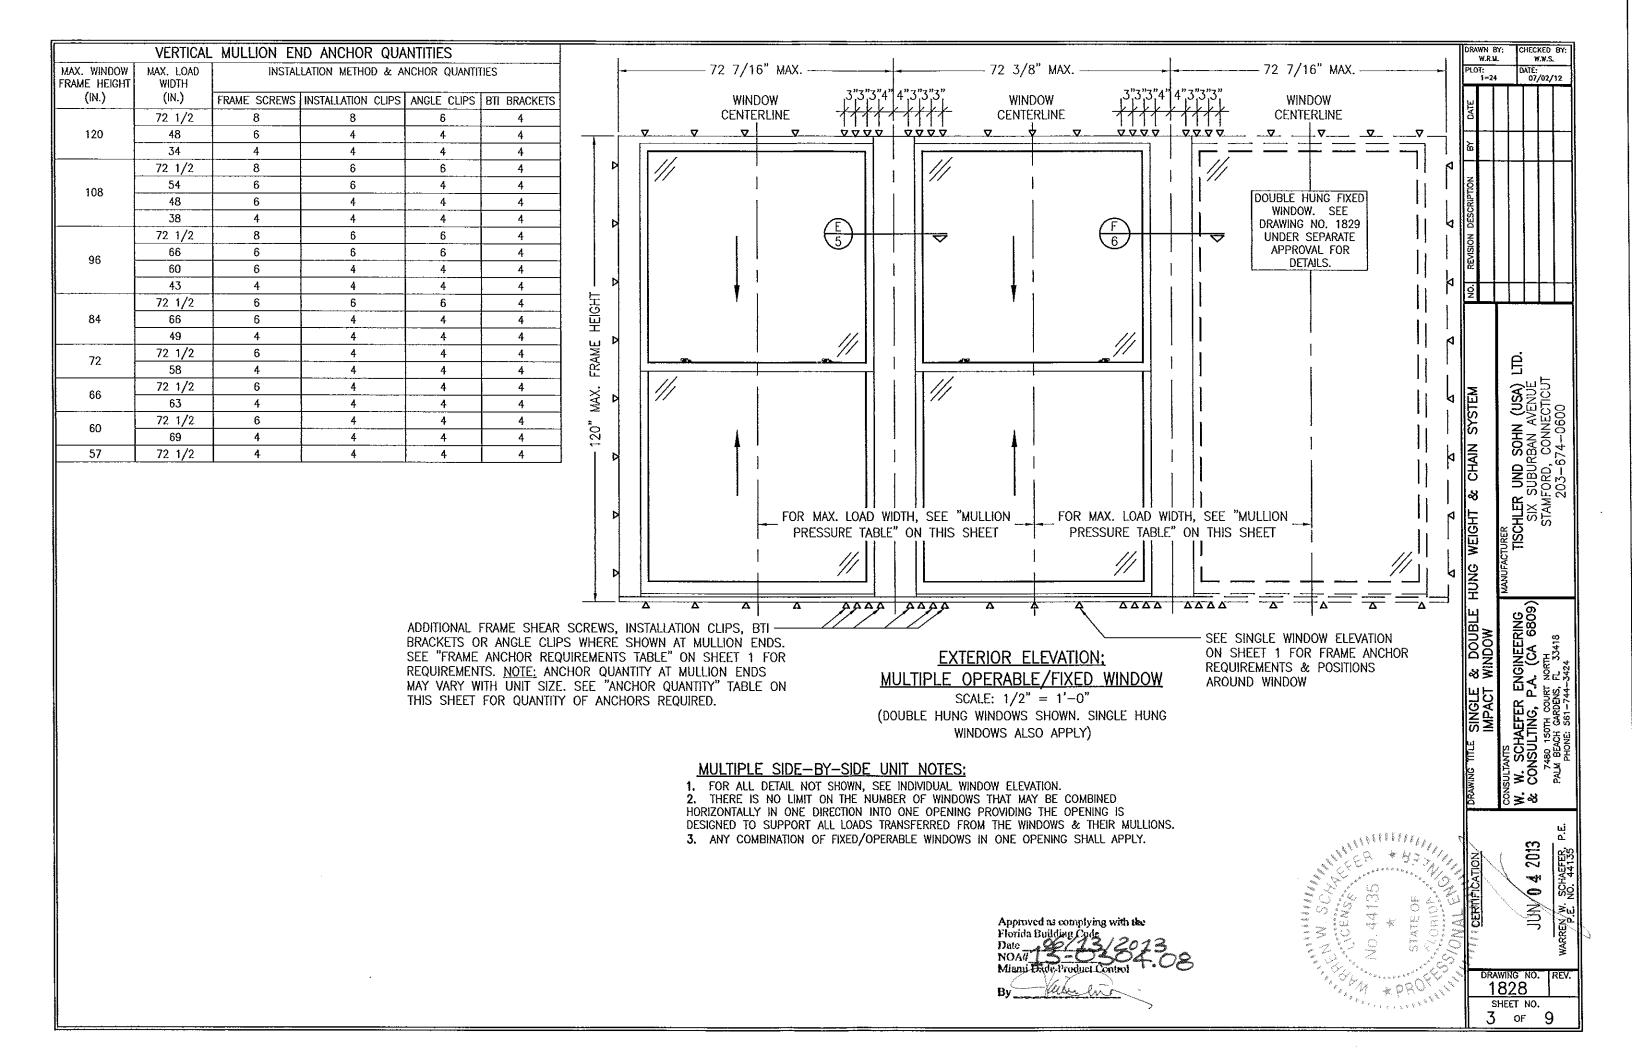

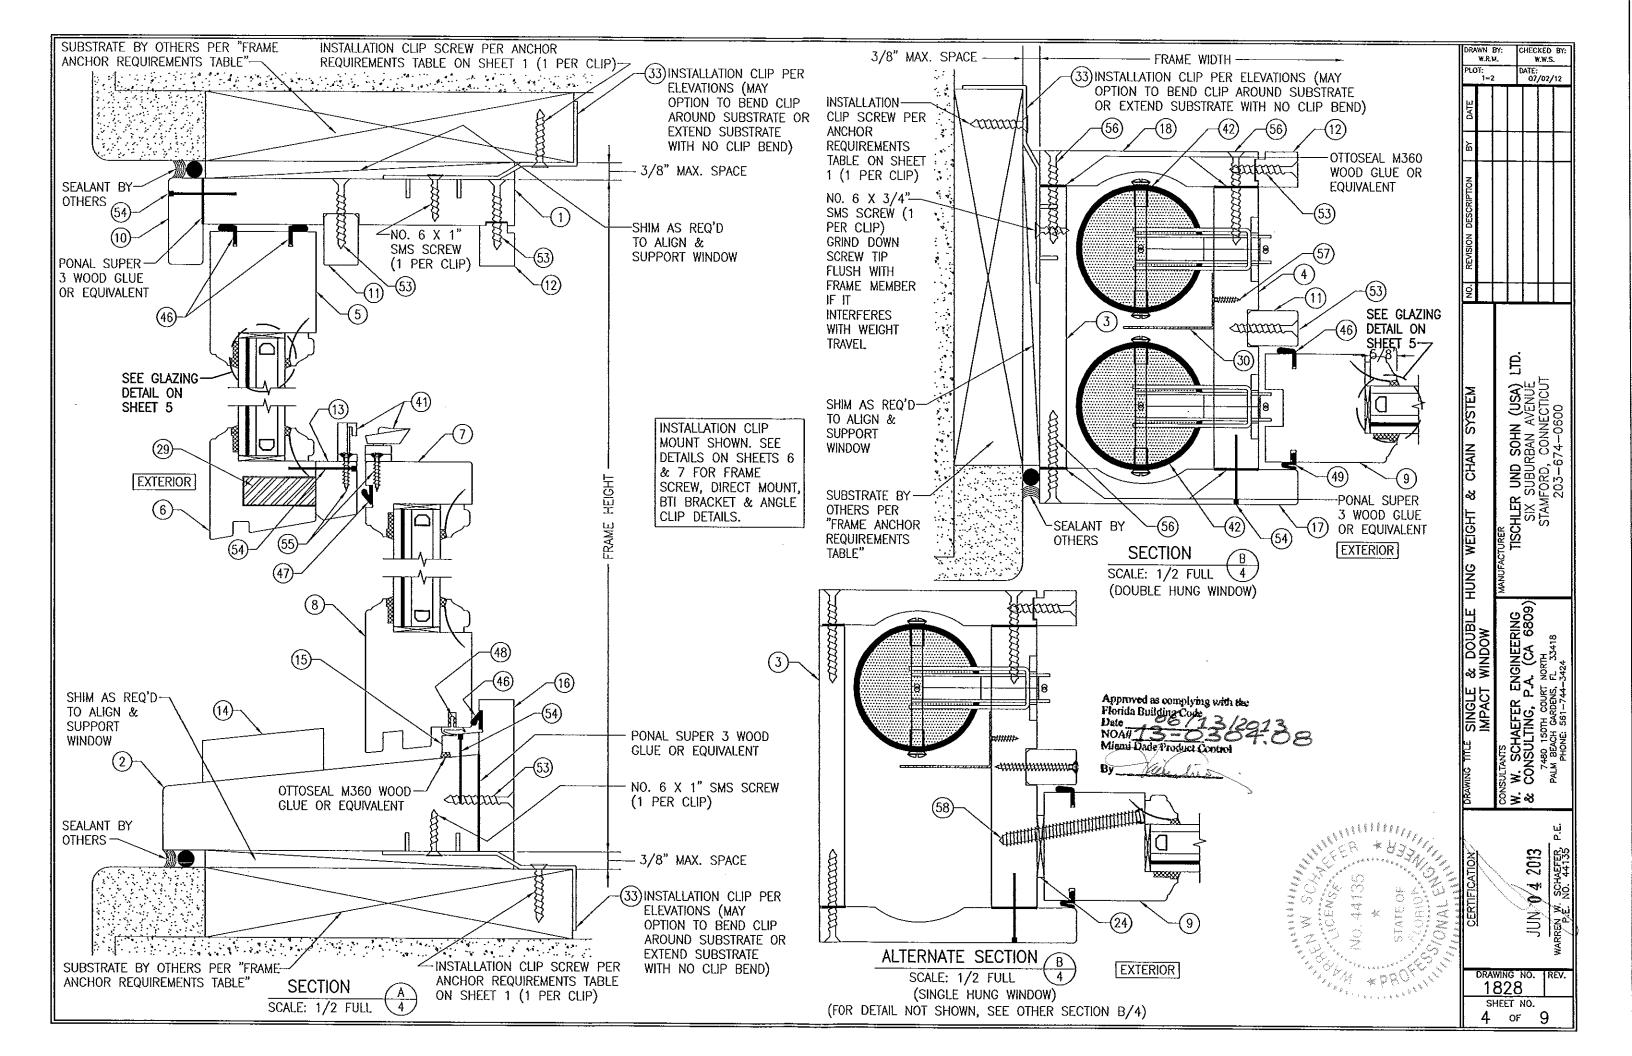

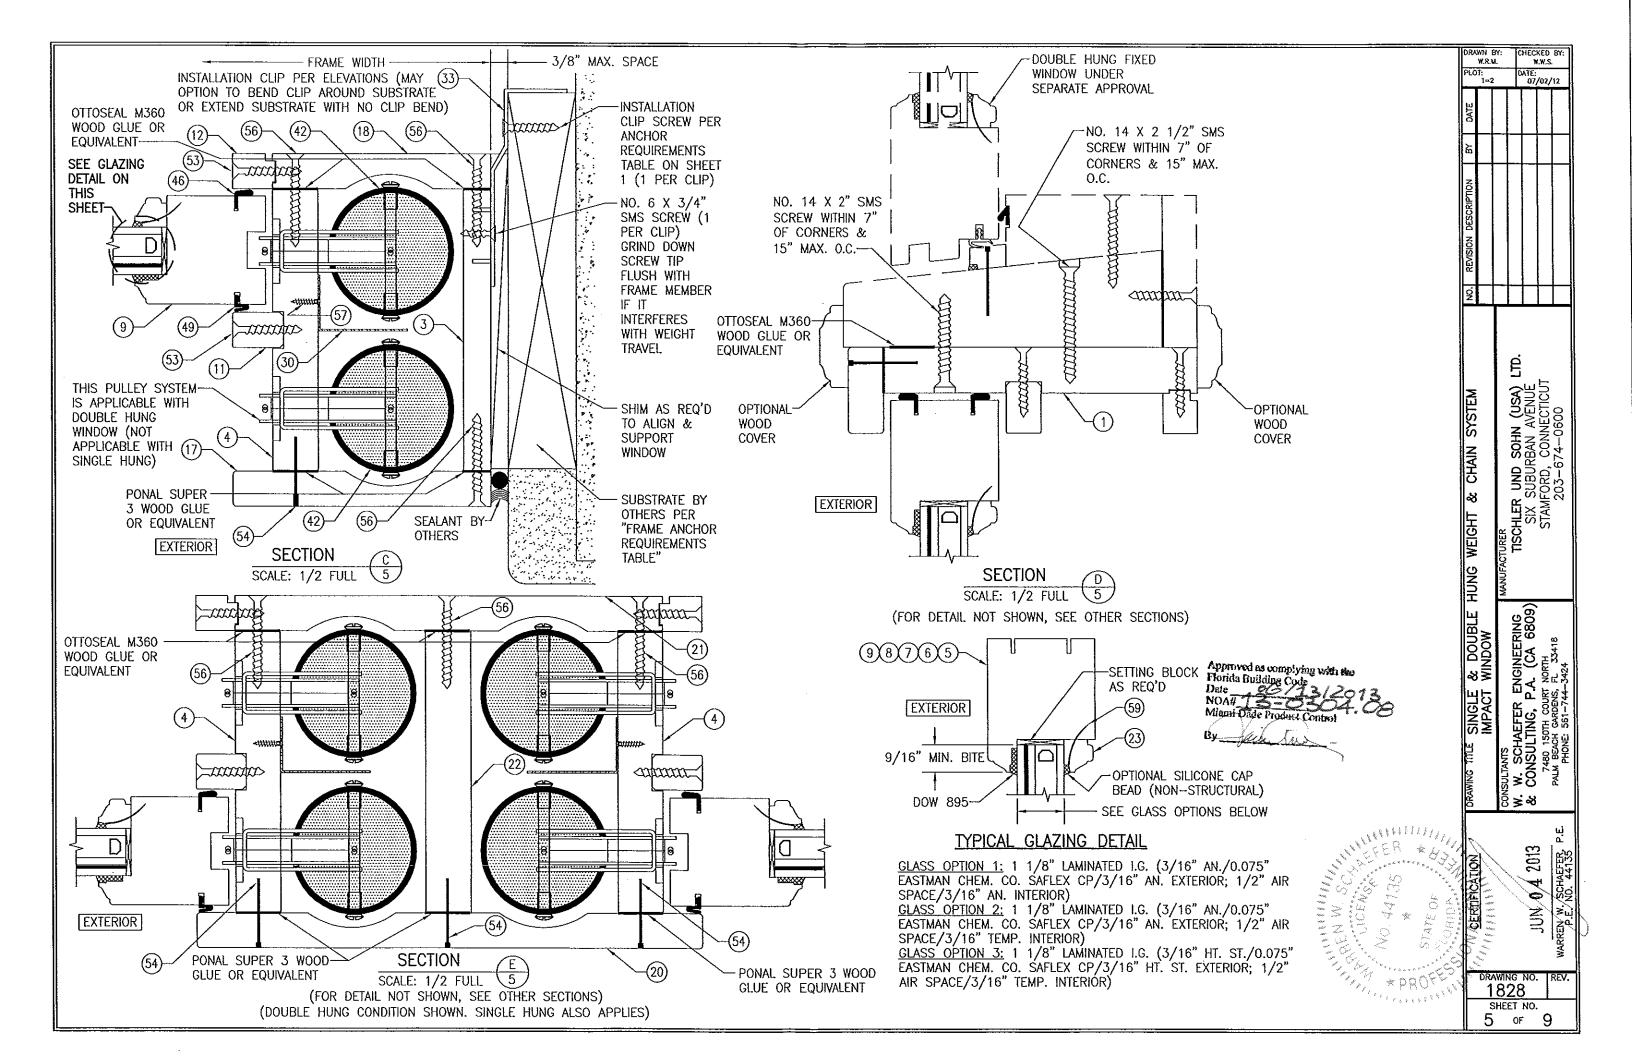


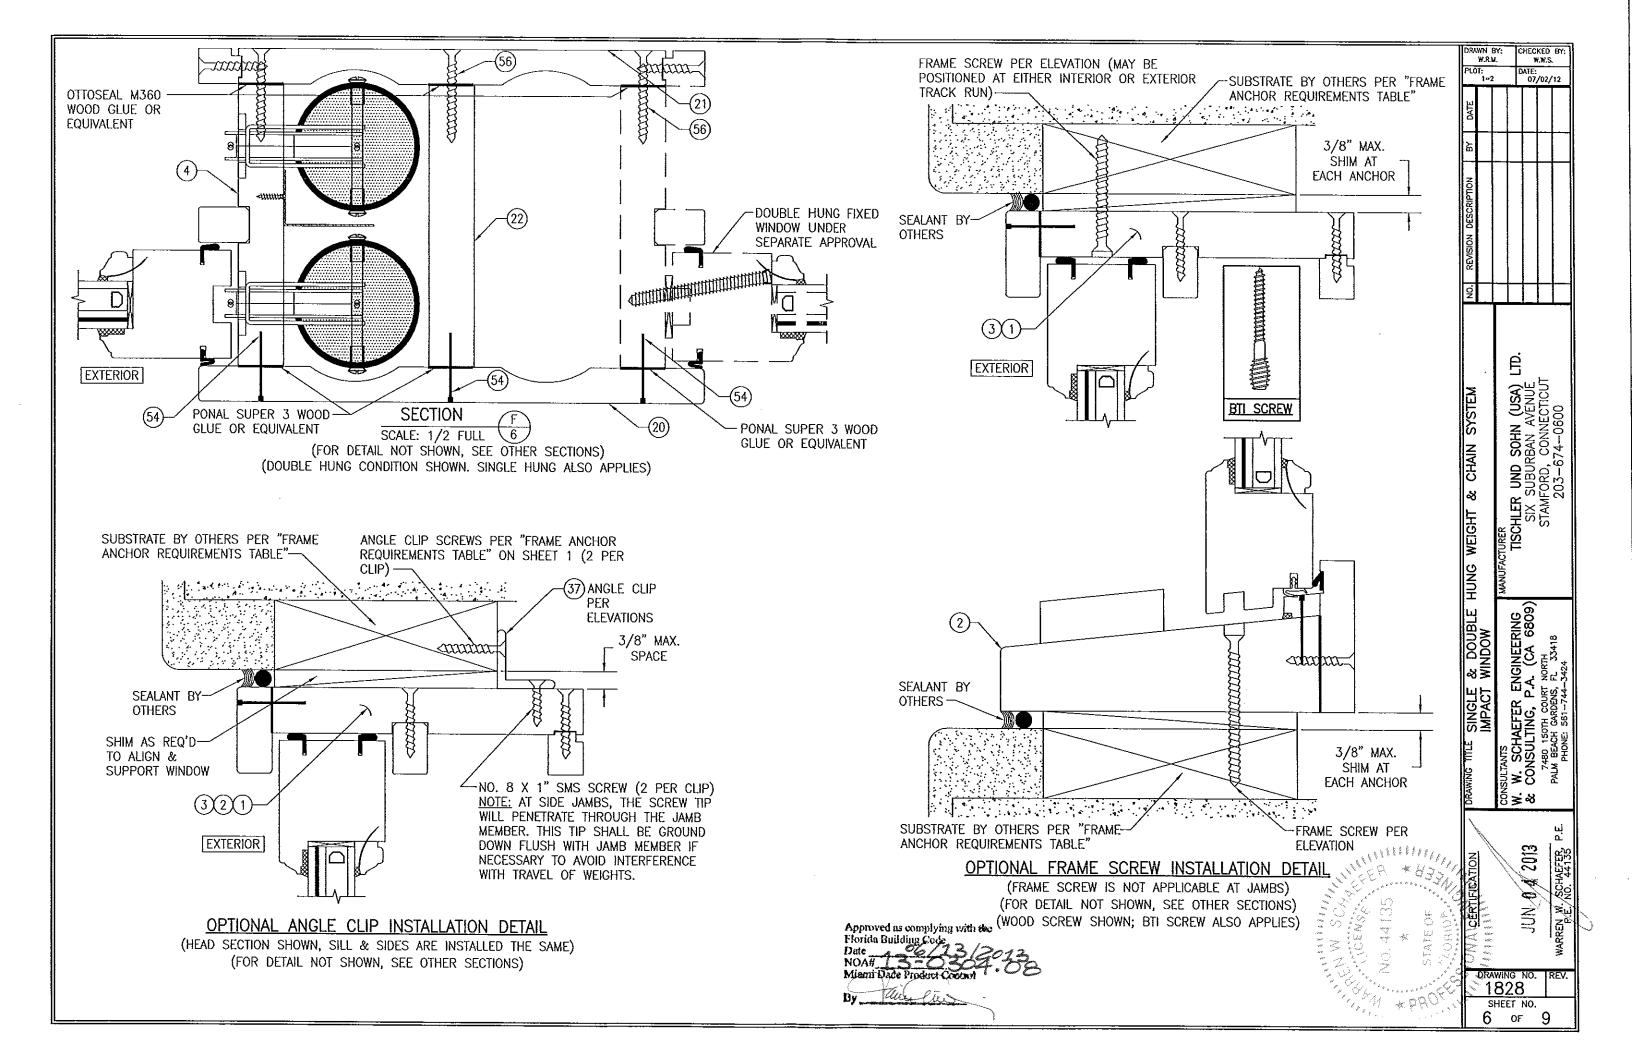

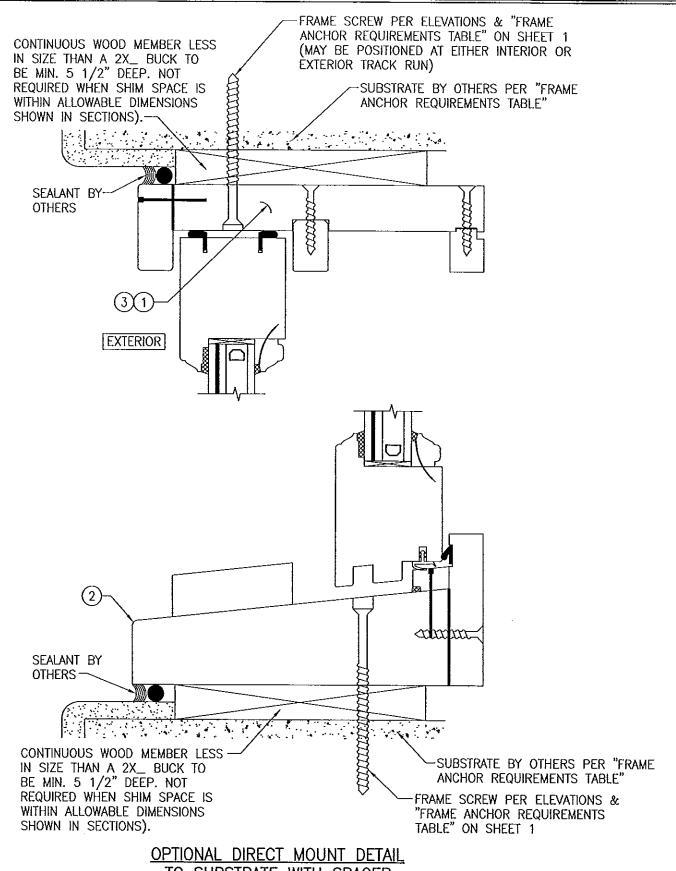


TO SUBSTRATE WITH SPACER

(FRAME SCREW IS NOT APPLICABLE AT JAMBS) (FOR DETAIL NOT SHOWN, SEE OTHER SECTIONS)

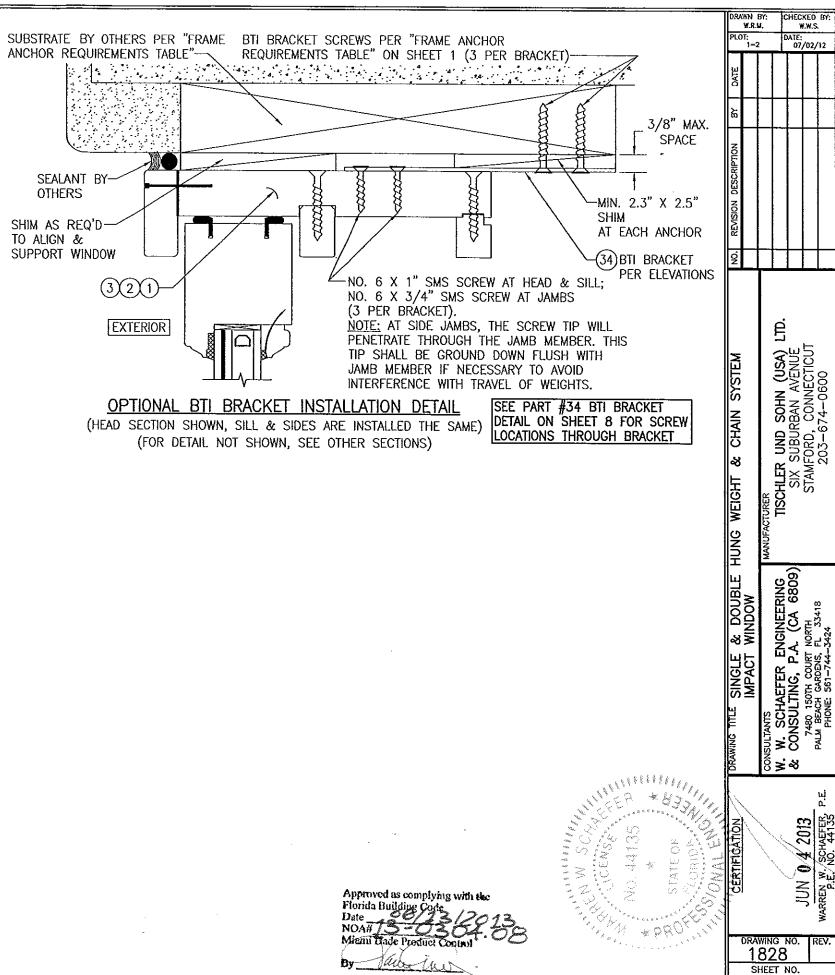

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ITEM #	ITEM DESCRIPTION	MANUFACTURER/NOTES
	PARTS	· · · · · · · · · · · · · · · · · · ·
1	HEAD	WOOD
2	SILL	WOOD
3	JAMB	WOOD
4	SUB-JAMB	WOOD
5	TOP RAIL	WOOD
6	TOP CHECK-RAIL	WOOD
7	BOTTOM CHECK-RAIL	WOOD
8	BOTTOM RAIL	WOOD
9	STILE	WOOD
10	HEAD/JAMB EXTERIOR SASH STOP	WOOD
11	PARTING STOP	WOOD
	HEAD/JAMB INTERIOR SASH STOP	WOOD
13	TOP CHECK-RAIL EXTENSION	WOOD
	WATER GUARD	WOOD
15	BOTTOM SASH STOP	WOOD
16	SILL INTERIOR SASH STOP	WOOD
17	JAMB EXTERIOR SASH STOP	WOOD
18	JAMB INTERIOR SASH STOP	WOOD
20	MULLION EXTERIOR SASH STOP	WOOD
	MULLION INTERIOR SASH STOP	WOOD
	MULLION INTERMEDIATE FRAME	WOOD
23	GLAZING BEAD	WOOD
24	SINGLE HUNG WINDOW SASH BLOCKING	WOOD
29	TOP CHECK-RAIL REINFORCEMENT	34 KSI STAINLESS STEEL OR A36 STEEL
	WEIGHT & CHAIN SEPERATOR	6063-T6 ALUMINUM
	INSTALLATION CLIP	GALVANIZED 54 KSI STEEL
34	BTI BRACKET	GALVANIZED 54 KSI STEEL
37	ANGLE CLIP	6061-T6 ALUMINUM
	HARDWARE	OCCI TO ALOMINOM
41	SASH LOCK & KEEPER	PHELPS LKF-14
42	WEIGHT & CHAIN SYSTEM:	THE O EM IT
	SASH STOP	VON MORRIS 2400X605 NL BRASS
	PULLEY	PHELPS SP225BB RE BRASS
	COUNTER WEIGHT	DOEBLER STEEL TUBE WITH GOSLER SOLID LEAD
	SEALS & SEALANTS	TOSEBLEN OFFICE TOPE THIT GOSELN SOLIO LEAD
46	WEATHERSTRIP	SCHLEGEL QWS-250
47	WEATHERSTRIP	SCHLEGEL QFS-375
48	SILL WEATHERSTRIP	DEVENTER S6961
49	WEATHERSTRIP	SCHLEGEL QL-3055
	FASTENERS	1
53	NO. 8 X 1 1/2" SMS OR WOOD SCREW	WITHIN 2" FROM CORNERS & 12" MAX. O.C.
54	18 GA. X 1 1/2" S.S. BRAD NAIL	WITHIN 2" FROM CORNERS & 12" MAX. O.C.
55	NO. 8 X 3/4" SMS OR WOOD SCREW	2 PER EACH SASH LOCK AND KEEPER
56	NO. 10 X 2" SMS OR WOOD SCREW	WITHIN 2" FROM ENDS & ONE AT MID-SPAN
57	NO. 6 X 13/16" SMS OR WOOD SCREW	WITHIN 3" FROM CORNERS & 8" MAX. O.C.
58	NO. 14 X 3 1/8" BAUTEC WOOD SCREW	WITHIN 4" FROM CORNERS & 12" MAX. O.C.
59	18 GA. X 1 1/2" S.S. CURVED NAIL	WITHIN 4" FROM CORNERS & 12" MAX. O.C.
NOTE: \		SPECIFIC GRAVITY OF G = 0.62 AND A MODULUS OF

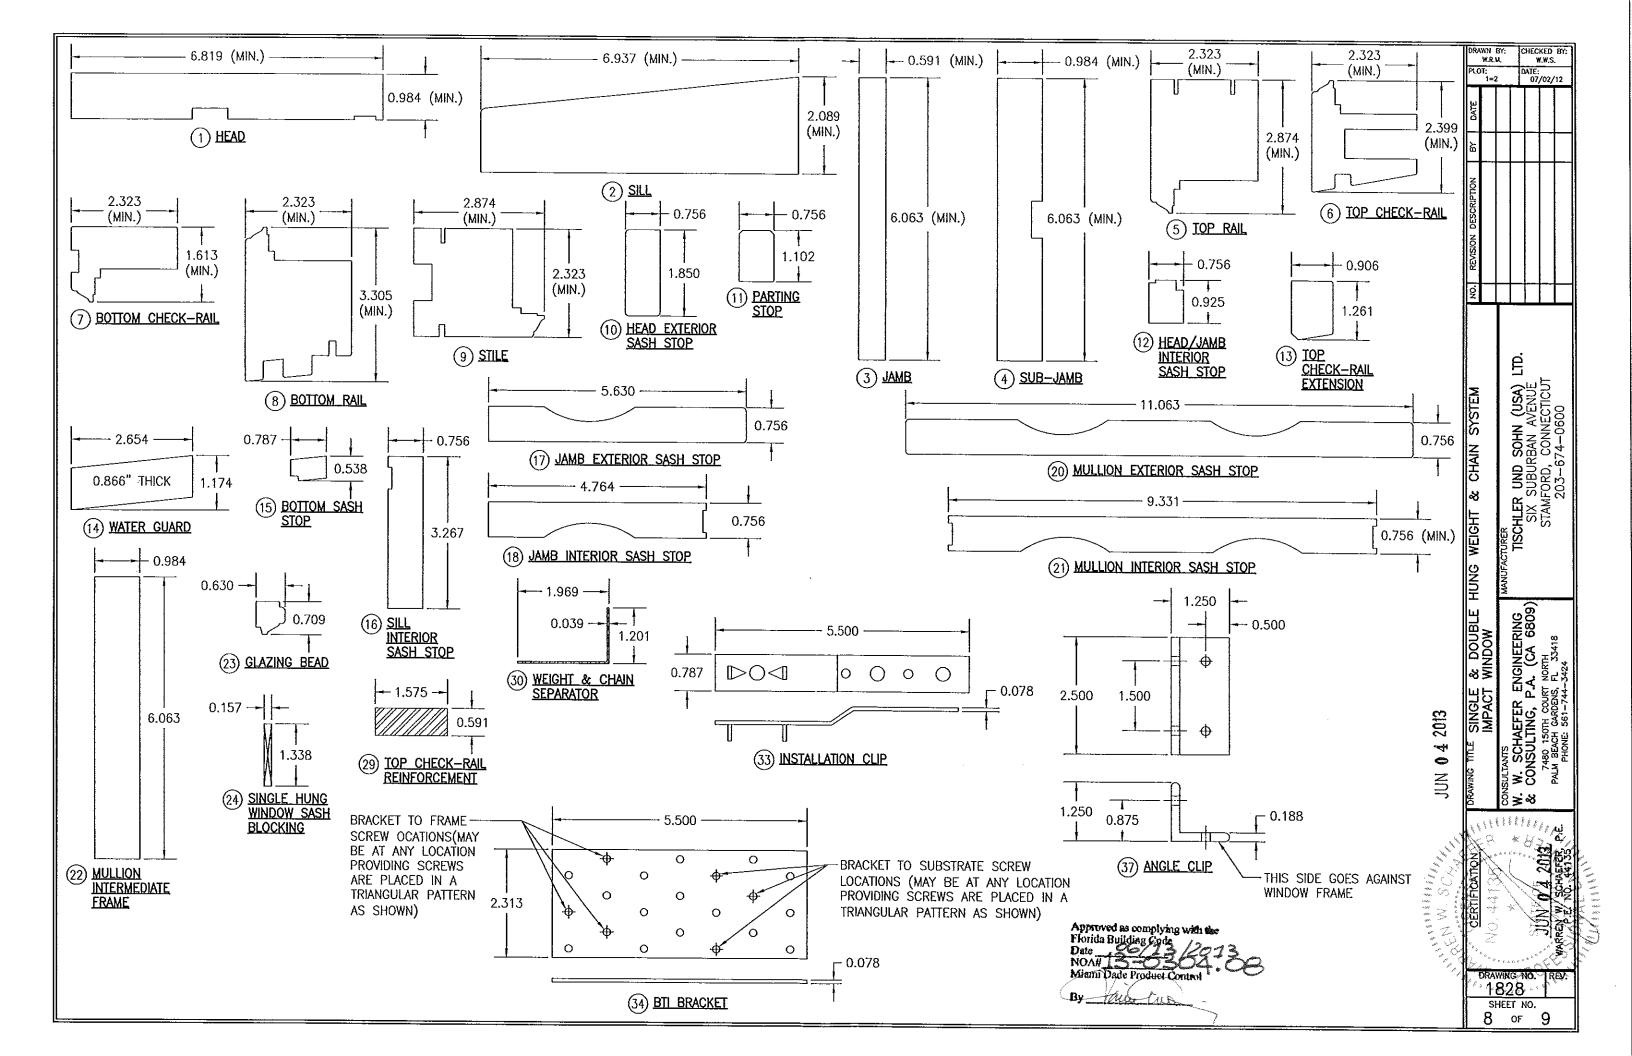E: WOOD USED IN TESTING WAS SIPO MAHOGANY WITH A SPECIFIC GRAVITY OF G = 0.62 AND A MODULUS OF ELASTICITY OF E = 1,6000,000 PSI. OTHER WOOD SPECIES APPLICABLE FOR USE WITH THIS PRODUCT ARE THOSE WITH A SPECIFIC GRAVITY OF 0.62 AND MODULUS OF ELASTICITY OF 1,600,000 PSI OR GREATER. ALL WOOD IS MINIMUM GRADE 2 MILLED BY TISCHLER UND SOHN TO SELECT.

Approved as complying with the Florida Building Code Date NOA# 3 - 08 Mismi Dade Product Control By

CERTIFICATION	DRAWING TITLE SINGLE & DOUBLE HUNG WEIGHT & CHAIN SYSTEM	JNG WEIGHT & CHAIN SYSTEM	ģ	REVISION DESCRIPTION	à	DATE	PLO
	IMPACT WINDOW						WN 1 W.R.i)T: 1=2
	CONSULTANTS	MANUFACTURER	_				BY:
	W. W. SCHAEFER ENGINEERING	TISCHLER UND SOHN (USA) LTD.				, 	- 1
TIM A 1 DOWN	& CONSULTING, P.A. (CA 6809)	SIX SUBURBAN AVENUÉ					CHEC N DATE: 07
ON 10 4 CUIS	7480 150TH COURT NORTH	STAMFORD, CONNECTICUT					N.W.S
N W. SCHAEFER, P.E. P.E. NO. 44135	PALM BEACH CARDENS, TC 55418 PHONE: 561-744-3424	203-674-0600					

DRAWING NO. REV. 1828 SHEET NO.

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